


COMPANY\1999 JOBS\99-044 AHTD\WHITERIVER\JOB 110395\368 Girder Unit 6 ACAD SCALE: 1/16"=1'-0"

DATE REVISED	DATE FILMED	DATE REVISED	DATE FILMED	FED. ROAD NO.	STATE	FED. AID PROJ. NO.	SHEET NO.	TOTAL SHEETS
					ARK.			
						JOB NO. 110395	70	203
						06830	368' UNIT	47067

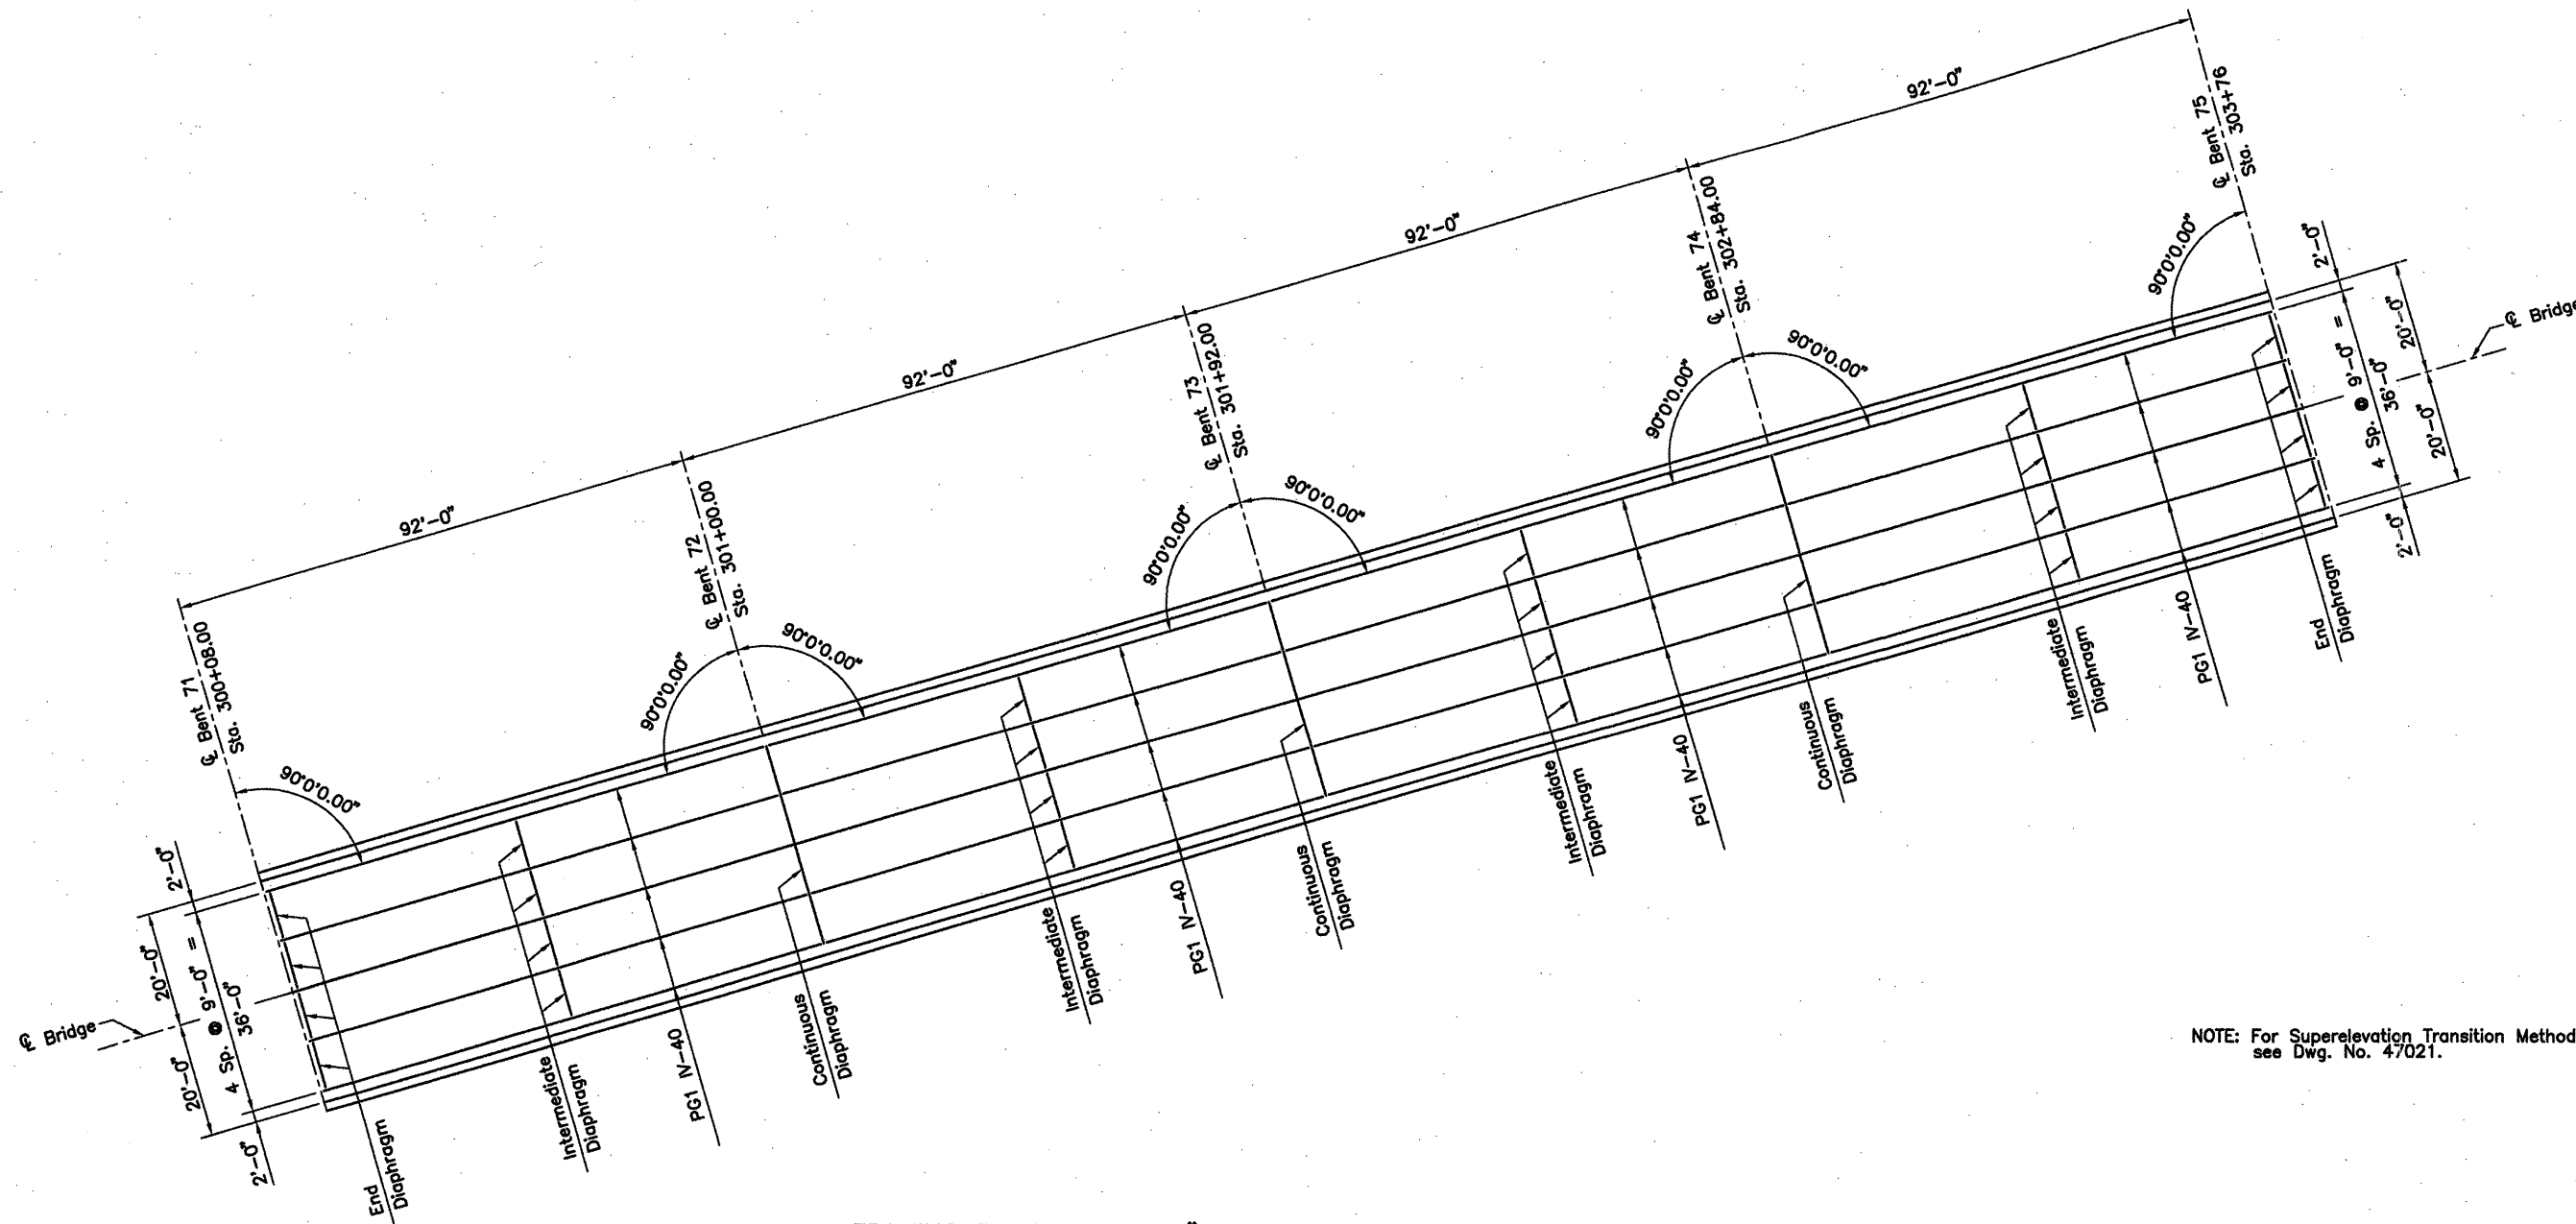

NOTE: For Superelevation Transition Method, see Dwg. No. 47021.

### FRAMING PLAN - 368'-0" CONT. PRESTRESSED CONCRETE GIRDER UNIT 7

Scale: 1/16" = 1'-0"

Station 300+08 to Station 303+76 (One Unit Required)

### ALTERNATE NO. 1

DETAILS OF 284', 330' & 368' CONT. PRESTRESSED CONCRETE GIRDER UNITS (SHEET 6 OF 19)

WHITE RIVER STR. & APPRS. (CLARENDON) (PH III) (F) MONROE COUNTY


ROUTE 79 SEC. 13

ARKANSAS STATE HIGHWAY COMMISSION  
LITTLE ROCK, ARK.

Engstrom/Modjeski and Masters, Inc.

DRAWN BY: YO DATE: Nov. 07 FILENAME: b11039512\_s05  
CHECKED BY: JES DATE: Nov. 01 SCALE: 1/16" = 1'-0"  
DESIGNED BY: YO DATE: Nov. 01

BRIDGE NO. 06830 DRAWING NO. 47067

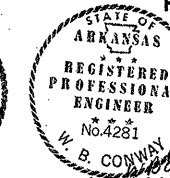

BRIDGE ENGINE EER